


GENERAL ELECTRICAL NOTES (APPLICABLE TO ALL DRAWINGS)				ELECTRICAL LEGEND			
1. CONTRACTOR SHALL COORDINATE ALL WORK WITH EXISTING, ARCHITECTURAL, STRUCTURAL, MECHANICAL, PLUMBING AND SPECIAL SYSTEMS DRAWINGS.				LIGHTING			
				LETTER ADJACENT TO LIGHT FIXTURE DESIGNATES LIGHT FIXTURE TYPE. REFER TO LIGHT FIXTURE SCHEDULE FOR TYPE AND SPECIFICATIONS. NOT ALL LIGHT FIXTURES SHOWN ON THE DRAWINGS MAY BE INDICATED IN THIS LEGEND. FINAL LOCATION OF ALL LIGHT FIXTURES SHALL BE COORDINATED WITH ARCHITECTURAL DRAWINGS PRIOR TO ROUGH-IN. ALL LIGHT FIXTURES SHALL BE INSTALLED WITH FIXTURE WHIPS AND J-BOXES AS REQUIRED.			
2. MATERIALS AND WORKMANSHIP SHALL COMPLY WITH THE CONTRACT DOCUMENTS, (INCLUDING BOTH DRAWINGS AND SPECIFICATIONS), INDUSTRY STANDARDS, AND IBC 2015 AND LOCAL AMENDMENTS AND APPLICABLE CODES.				EQUIPMENT AND DEVICES			
				SYMBOL DESCRIPTION AND/OR COMMENTS			
3. THE CONTRACTOR SHALL LOCATE DEVICES AND OUTLETS AT LOCATIONS SHOWN ON THE DRAWINGS AND SHALL COORDINATE EXACT LOCATIONS WITH OWNERS EQUIPMENT AND EXISTING, ARCHITECTURAL DRAWINGS, AND MILLWORK SHOP DRAWINGS.				GROUND--FAULT CIRCUIT INTERRUPTING RECEPTACLE. MOUNT AT 18" TO CENTER OF DEVICE UNLESS INDICATED OTHERWISE. SUBSCRIPT DESIGNATOR: EWC--ELECTRIC WATER COOLER GROUND--FAULT CIRCUIT INTERRUPTING RECEPTACLE. MOUNT BEHIND WATER COOLER IN AN ACCESSIBLE LOCATION TO ALLOW OPERATION OF TEST AND RESET BUTTONS ON RECEPTACLE. WP--GROUND FAULT CIRCUIT INTERRUPTING DUPLEX RECEPTACLE 125VAC, 20A, NEMA 5-20R WITH WHILE-IN-USE COVER. MOUNT AT 18" TO CENTER OF DEVICE UNLESS OTHERWISE NOTED. REFER TO ARCHITECTURAL DRAWING FOR EXACT LOCATION.			
				TOGGLE SWITCH, 120/277V, 20A, UP 48" UNLESS OTHERWISE NOTED. SUBSCRIPT DESIGNATOR: 3--THREE-WAY TOGGLE SWITCH. OC--WALL-MOUNTED OCCUPANCY SENSOR. UP 48". REFER TO CONTROL DIAGRAM. T -- FRACTIONAL -- HORSEPOWER MANUAL STARTER/DISCONNECT SWITCH WITH MELTING-ALLOY--TYPE THERMAL OVERLOAD 1HP RATED.			
4. ALL MATERIALS AND EQUIPMENT SHALL BE INSTALLED IN ACCORDANCE WITH MANUFACTURERS' PUBLISHED RECOMMENDATIONS FOR SERVICE INTENDED, AS INTERPRETED BY THE ENGINEER. THE INSTALLATION OF ALL THE MATERIALS AND EQUIPMENT SHALL BE PERFORMED BY EXPERIENCED AND LICENSED PERSONNEL.				WIRE MOLD NON--METALIC SURFACE RACEWAY SUBSCRIPT DESIGNATOR: A--WIRE MOLD, 5400 TBWH SERIES WITH 5450T AND 5507D DEVICE PLATES AND BRACKETS AND 5410D ENTRANCE END FITTING. MOUNTED AT LOCATIONS AND SPACING AS SHOWN ON POWER AND SPECIAL SYSTEMS PLANS. CONNECT RECEPTABLES TO CIRCUITS AS SHOWN ON POWER DRAWINGS PROVIDE DATA BRACKETS INSERTS WHERE SHOWN ON SPECIAL SYSTEMS DRAWINGS. COORDINATE LOCATION OF DATA DROPS WITH COMMUNICATIONS CONTRACTOR PRIOR TO INSTALLATION. B--WIRE MOLD, 800 BACWH SERIES WITH 2347 AND 5507 DEVICE BOXES AND PLATES AND 810A ENTRANCE END FITTING MOUNTED AT LOCATIONS AND SPACING AS SHOWING ON POWER DRAWINGS. COORDINATE EXACT LOCATIONS WITH GENERAL CONTRACTOR PRIOR TO INSTALLATION.			
				WALL MOUNTED DUAL TECHNOLOGY OCCUPANCY SENSOR, MOUNT AT 6" BELOW CEILING TO TOP OF DEVICE.			
5. PROVIDE COMPLETE RACEWAY SYSTEM FOR ALL WIRING UNLESS SPECIFICALLY NOTED OTHERWISE. THIS INCLUDES, BUT IS NOT LIMITED TO: A. FEEDER WIRING B. BRANCH CIRCUIT WIRING C. CONTROL WIRING D. FIRE ALARM WIRING E. CCTV WIRING F. SECURITY SYSTEMS G. OTHER AUXILIARY SYSTEMS WIRING. H. PUBLIC ADDRESS				CEILING MOUNTED DUAL TECHNOLOGY OCCUPANCY SENSOR.			
				LIGHTING ROOM CONTROLLER/POWER PACK, REFER TO LIGHTING CONTROL DIAGRAMS FOR EXACT REQUIREMENTS			
WIRING METHODS i) CONCEAL ALL RACEWAYS EXCEPT IN MECHANICAL/ELECTRICAL EQUIPMENT ROOMS WITH MASONRY WALLS. INSTALL RACEWAYS AT LEAST 6 INCHES AWAY FROM ANY HEAT PRODUCING ITEMS. ii) PROVIDE ADEQUATE AND STURDY SUPPORT FOR ALL PARTS OF RACEWAY SYSTEMS. INSTALL NYLON PULL CORD IN ALL EMPTY RACEWAYS.				ROOF MOUNTED GFCI DUPLEX RECEPTACLE, WEATHERPROOF WITH WHILE IN USE COVER.			
				MOTOR WITH HORSEPOWER INDICATED.			
6. THE FOLLOWING SYSTEMS THE CONTRACTOR MAY USE PLENUM/LOW SMOKE CABLES FOR CLASS 1 POWER LIMITED CIRCUITS AND INSTALLED PER WIRING METHODS INDICATED BELOW. A. COMMUNICATIONS WIRING B. TELEPHONE WIRING C. DATA WIRING				WALL MOUNTED 4--11/16 X 4--11/16 X 2--1/8 BOX FOR CONNECTION OF POWER CABLING TO MODULAR FURNITURE. PROVIDE MODULAR FURNITURE CONNECTION AND WHIP PER NEC AND FURNITURE MANUFACTURES REQUIREMENTS.			
				T'STAT BY MECHANICAL. ROUGH--IN BY ELECTRICAL. REFER TO T'STAT ROUGH--IN DETAIL.			
WIRING METHODS. i) PROVIDE INDEPENDENT SUPPORT FROM THE BUILDING STRUCTURE FOR EACH WIRING SYSTEMS AT NOT TO EXCEED 36 INCHES OR CLOSER IF REQUIRED IN THE NATIONAL ELECTRICAL CODE (NFPA--70). ii) CONCEAL ALL WIRING EXCEPT IN MECHANICAL/ELECTRICAL EQUIPMENT ROOMS. iii) INSTALL WIRING AT LEAST 36 INCHES AWAY FROM ANY HEAT PRODUCING ITEMS. iv) PROVIDE RACEWAYS FOR ALL WIRING RUNS IN INACCESSIBLE WALLS, SHAFTS, OR CEILING SPACES. PROVIDE ADEQUATE AND STURDY SUPPORT FOR ALL PARTS OF RACEWAY SYSTEMS. INSTALL NYLON PULL CORD IN ALL EMPTY RACEWAYS. v) COMPLY WITH NATIONAL ELECTRICAL CODE (NFPA--70) REQUIREMENTS. vi) RUN WIRING PARALLEL TO BUILDING ARCHITECTURAL AND STRUCTURAL COMPONENTS.				PULL BOX. SIZE AS REQUIRED.			
				POWER POLE.			
7. CONTRACTOR SHALL TAKE PROPER PRECAUTIONS TO PROTECT ALL EXISTING FACILITIES, UTILITIES, AND PROPERTY. CONTRACTOR SHALL ALSO TAKE PROPER PRECAUTIONS OVER PROPERTY WHICH HE MAY TRANSPORT, HOIST OR MOVE MATERIAL, EQUIPMENT, AND DEBRIS AND SHALL REPAIR TO ARCHITECT'S SATISFACTION ALL DAMAGES CAUSED DURING CONSTRUCTION. THE CONTRACTOR SHALL COORDINATE AND NOTIFY THE BUILDING OWNER FOR APPROVAL AND SCHEDULING OF ANY BUILDING SYSTEM INTERRUPTION.				ELECTRIC METER.			
				GROUND PER NEC UNLESS INDICATED OTHERWISE.			
8. ALL EQUIPMENT SHALL BE INSTALLED IN ACCORDANCE WITH MANUFACTURER'S PUBLISHED RECOMMENDATIONS FOR SERVICE INTENDED AS INTERPRETED BY THE ENGINEER. THE INSTALLATION OF ALL EQUIPMENT SHALL BE MADE BY EXPERIENCED CRAFTSMAN IN A NEAT WORKMANLIKE MANNER. ALL MATERIALS, TOOLS, COSTS AND SERVICES NECESSARY TO COMPLETELY INSTALL ALL ELECTRICAL WORK SHALL BE FURNISHED BY THE CONTRACTOR.				RACEWAY AND BRANCH CIRCUITING			
				SYMBOL DESCRIPTION AND/OR COMMENTS			
9. CIRCUIT BREAKERS FOR INSTALLATION IN EXISTING PANELBOARDS SHALL BE BY THE MANUFACTURER OF THAT PANELBOARD. MATCH THE SHORT CIRCUIT RATING OF THE EXISTING PANEL RATINGS. NEW EQUIPMENT FOR DISTRIBUTION SHALL MATCH EXISTING EQUIPMENT.				HOME RUN TO PANEL & CIRCUIT INDICATED. REFER TO PANEL SCHEDULES FOR CONDUIT AND WIRE SIZES UNLESS INDICATED OR NOTED OTHERWISE.			
				CONDUIT (SIZE AS NOTED) WITH PULL WIRE STUBBED WHERE INDICATED. PROVIDE BUSHING AT END OF CONDUIT.			
10. ALL OUTAGES OF ELECTRICAL UTILITIES, ELECTRICAL SERVICE TO AREAS, OUTAGES OF FIRE ALARM SYSTEMS, COMMUNICATIONS SYSTEMS, SECURITY SYSTEMS, AND TELEPHONE AND DATA SYSTEMS SHALL BE SCHEDULED WITH AND APPROVED BY THE OWNER PRIOR TO THE OUTAGE.				LINE TYPE INDICATES EXISTING TO REMAIN ELECTRICAL, DEVICES, EQUIPMENT, ECT.			
				LINE TYPE INDICATES EXISTING TO BE DEMOLISHED ELECTRICAL EQUIPMENT, DEVICES, ETC.			
11. THE TERM "PROVIDE" USED IN THE DRAWINGS AND SPECIFICATIONS IMPLIES THE CONTRACTOR IS TO FURNISH, TRANSPORT, INSTALL, CONNECT, WARRANT AND START--UP, INCLUSIVELY.				LINE TYPE INDICATES NEW ELECTRICAL DEVICES, EQUIPMENT, ETC.			
				SECOND AND THIRD MODIFIER. DESIGNATES CIRCUIT TYPE. (SEE BELOW) FIRST MODIFIER. "O" DESIGNATES OVERHEAD, "U" DESIGNATES UNDERGROUND, "S" DESIGNATES SURFACE.			
12. CIRCUITING SHOWN IS DIAGRAMMATIC ONLY, INDICATING CIRCUIT NUMBERS. CONTRACTOR SHALL EXTEND HOT, NEUTRAL, SWITCH--LEG AND GROUND CONDUCTORS TO ALL ELECTRICAL EQUIPMENT INDICATED TO PROVIDE A FULLY FUNCTIONAL SYSTEM.				OE OVERHEAD ELECTRICAL.			
				UE UNDERGROUND ELECTRICAL.			
13. PROVIDE BRANCH CIRCUIT WIRING FOR ALL POWER AND LIGHTING CIRCUITS. WIRE SIZE SHALL BE A MINIMUM OF #12 THWN COPPER IN 1/2" RIGID, EMT OF METALLIC FLEXIBLE CONDUIT. PROVIDE #10 WIRE FOR ALL CIRCUITS FARTHER THAN 100 FEET. ALL RACEWAYS SHALL CONTAIN A GREEN INSULATED GROUND WIRE SIZED PER N.E.C. BRANCH CIRCUITS SHALL HAVE FULL SIZE DEDICATED NEUTRALS.				EUE EXISTING UNDERGROUND ELECTRICAL.			
				OT OVERHEAD TELEPHONE.			
14. PROVIDE LARGER CONDUCTORS AS REQUIRED TO ACCOUNT FOR DERATING OF CONDUCTORS DUE TO TEMPERATURES ABOVE AMBIENT CONDITIONS, PER NOTE 8 OF N.E.C. AMPACITY TABLES AND FOR VOLTAGE DROP.				UT UNDERGROUND TELEPHONE.			
				OME OVERHEAD MEDIUM VOLTAGE ELECTRICAL (13.8KV).			
15. REGARDLESS OF CIRCUITING INDICATED ON THE DRAWINGS THE CONTRACTOR SHALL BALANCE THE LOADS BETWEEN PHASES ON ALL EXISTING AND NEW PANELBOARDS WITHIN SCOPE OF WORK. UPDATE PANEL DIRECTORIES.				UME UNDERGROUND MEDIUM VOLTAGE ELECTRICAL (13.8KV).			
				OT/D OVERHEAD TELEPHONE/DATA.			
16. PROVIDE ELECTRIC SERVICE REQUIRED BY ALL TRADES INVOLVED IN THE CONSTRUCTION OF THE PROJECT, RECEPTABLES, CORDS, LIGHTS AND LEVELS OF ILLUMINATION SHALL CONFORM TO OSHA, NEC AND LOCAL CODES AND ORDINANCES. PROVIDE TEMPORARY POWER TO THE SITE WHEN REQUIRED.				UT/D UNDERGROUND TELEPHONE/DATA.			
				GENERAL			
17. PROVIDE ENGRAVED NAMEPLATES ATTACHED WITH SCREWS ON ALL NEW AND EXISTING PANELS, ENCLOSURES AND EQUIPMENT WITHIN THE SCOPE OF WORK.				DETAIL SYMBOL --USED WHEN DETAIL IS SHOWN ON ANOTHER SHEET			
				SECTION OR DETAIL IDENTIFICATION LETTER FOR SECTION NUMBER FOR DETAIL NUMBER OF SHEET ON WHICH THE CONDITION IS DRAWN			
18. PROVIDE LOCK--ON HANDLES FOR ALL BREAKERS SERVING EMERGENCY AND EXIT LIGHTS. PROVIDE SWITCHING DUTY BREAKERS FOR ALL UNSWITCHED LIGHTING CIRCUITS.				REFER TO [] RE: 1/3			
19. THE TERM "ON" USED IN THE CIRCUITING IMPLIES THE CIRCUIT IS SHARED WITH OTHER DEVICES WITH SAME CIRCUIT NUMBER AND TERM.							
20. SPECIAL SYSTEMS CONTRACTORS SHALL MODIFY THE EXISTING SYSTEMS AS REQUIRED TO PROVIDE EXTENSION OF EACH SYSTEM. THE CONTRACTORS SHALL THEREFORE BE RESPONSIBLE AND WARRANT THE PROPER OPERATION OF EACH SYSTEM IN ITS ENTIRETY.							
21. INSTALL RECEPTABLES WITH GROUND PRONG FACING UP. LABEL RECEPTACLE AND SWITCH PLATES WITH PANEL AND CIRCUIT NUMBER.							
22. PANEL BOARDS SHALL HAVE COPPER BUSING. FULL SIZE NEUTRALS, NEUTRAL BARS, GROUND BARS, PANEL DIRECTORIES, LOCKABLE DOOR--IN--DOOR CONSTRUCTION. PROVIDE NAMEPLATE, VOLTAGE AND ARC FLASH LABELS PER N.E.C.							

- KEYED NOTES**
- 1 COORDINATE WITH NEW MEXICO TECH ON ROUTING AND PRIMARY SIZE REQUIREMENTS.
 - 2 REFER TO ELECTRICAL RISER DIAGRAMS ON SHEET E4.0 FOR ADDITIONAL INFORMATION OF CONCRETE ENCASED SECONDARY CONDUCTORS AND CONDUITS.
 - 3 NEW OWNER PROVIDED 300KVA SERVICE TRANSFORMER TO SERVE NEW SWITCHBOARD "MSB" IN WEST HALL. CONTRACTOR SHALL COORDINATE WITH OWNER EXACT LOCATION AND WORK REQUIRED.
 - 4 NEW 3Ø, NEMA 3R, FUSED SERVICE DISCONNECT. PENETRATE CONDUIT AT A HEIGHT ABOVE THE FIRST FLOOR CEILING GRID IN NEAREST ACCESSIBLE LOCATION TO ALLOW CONDUIT TO BE CONCEALED IN CEILING SPACE THROUGHOUT.
 - 5 NEW SERVICE METER SHALL BE E-MON D-MON, 3Ø, 4W, WYE, 120/208V. CONTRACTOR SHALL PROVIDE CT'S FULLY RATED OF TRANSFORMER LOAD AND SHALL BE INSTALLED INSIDE SERVICE DISCONNECT.

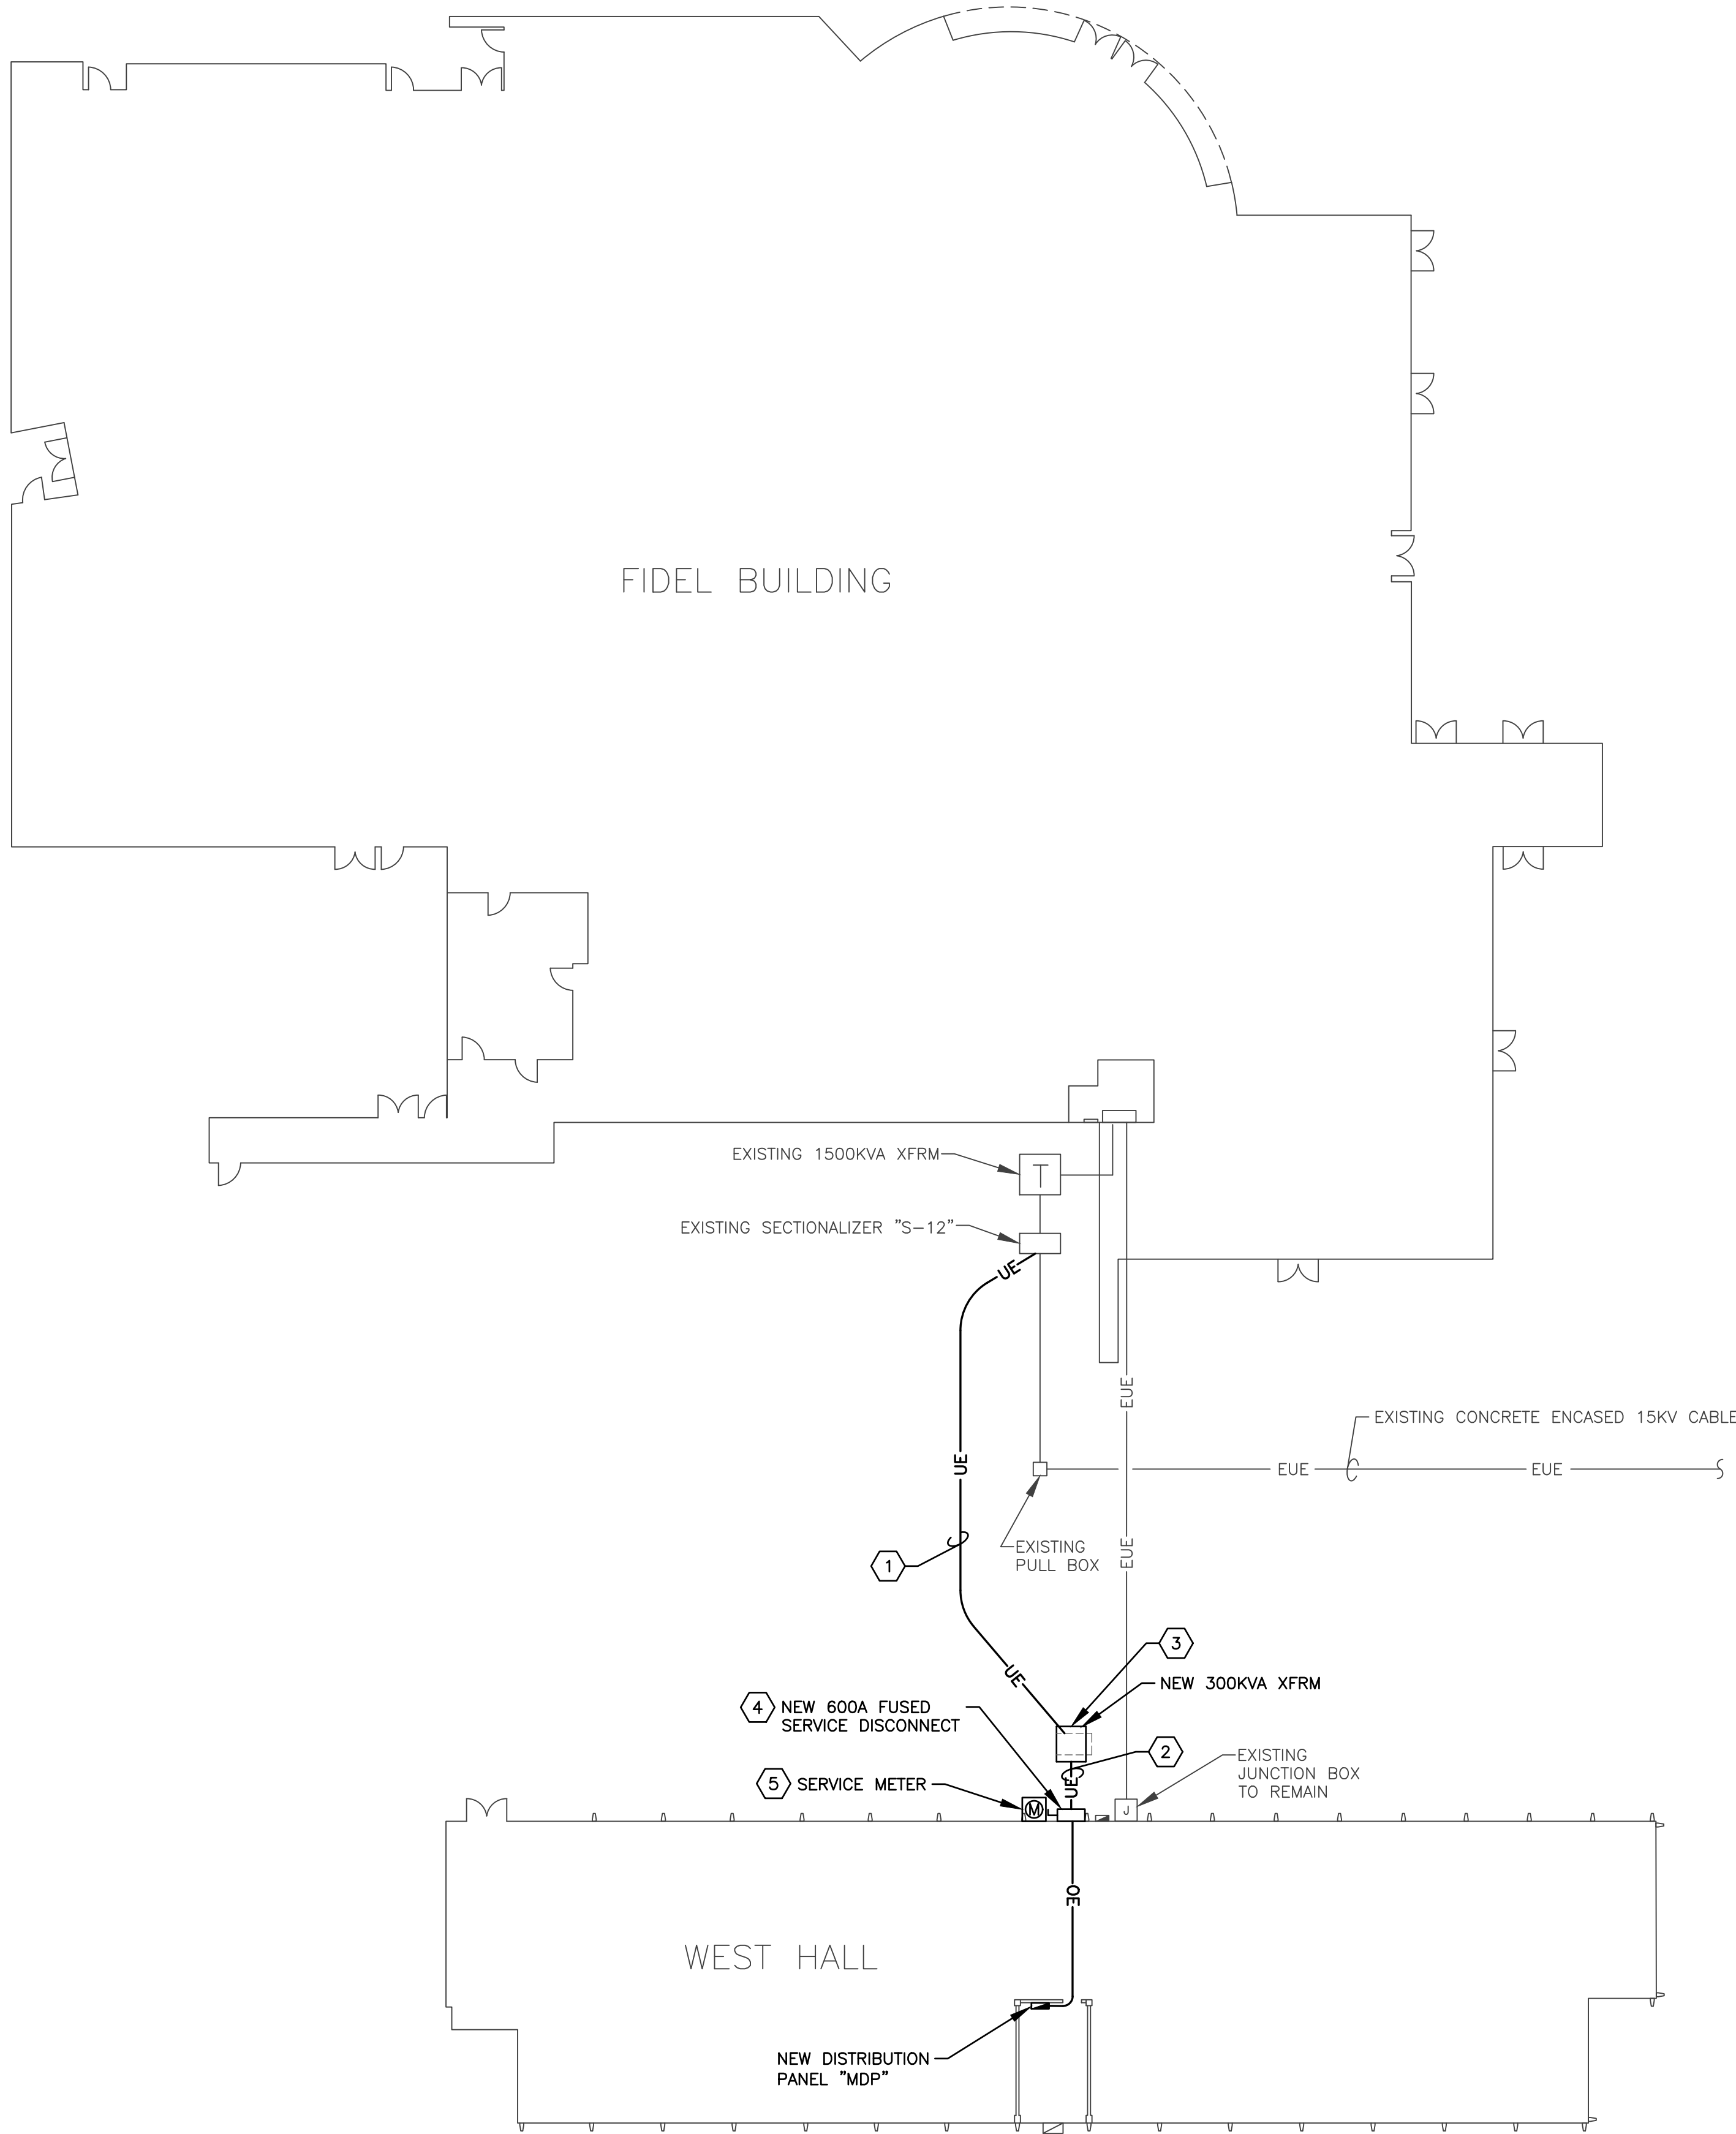


ELECTRICAL SITE PLAN - REVISED

SCALE: 1"=20'-0"

0 4' 8' 16'

1
E1.0

				DESIGNED ES	<p>"This preliminary drawing is released for the purpose of owner review under the authority of Javier Garcia, P.E., New Mexico Professional Engineer Number 14699 on January 26, 2021. This drawing is not to be used for construction, bidding, or permitting purposes. Alterations of this document is an offense under the New Mexico Engineering Practice Act."</p>	 <p>TEXAS FIRM REGISTRATION NO. 829 4110 RIO BRAVO SUITE 102 EL PASO, TX 79902 TEL: 915-313-7200</p>	ELECTRICAL SITE PLAN - REVISED		JOB NO. 3619
				DRAWN CAD					DRAWING NO. E1.0
				CHECKED JG					
				DATE 01/15/20			NEW MEXICO TECH WEST HALL		
REV.	DATE	BY	DESCRIPTION						

1. CONTRACTOR SHALL REMOVE ASSOCIATED CONDUIT AND WIRING BACK TO SOURCE FROM MECHANICAL EQUIPMENT BEING DEMOLISHED.




SCALE: 1/8"=1'-0"




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1 FIRST FLOOR ELECTRICAL PLAN - REVISED

SCALE: 1/8"=1'-0"

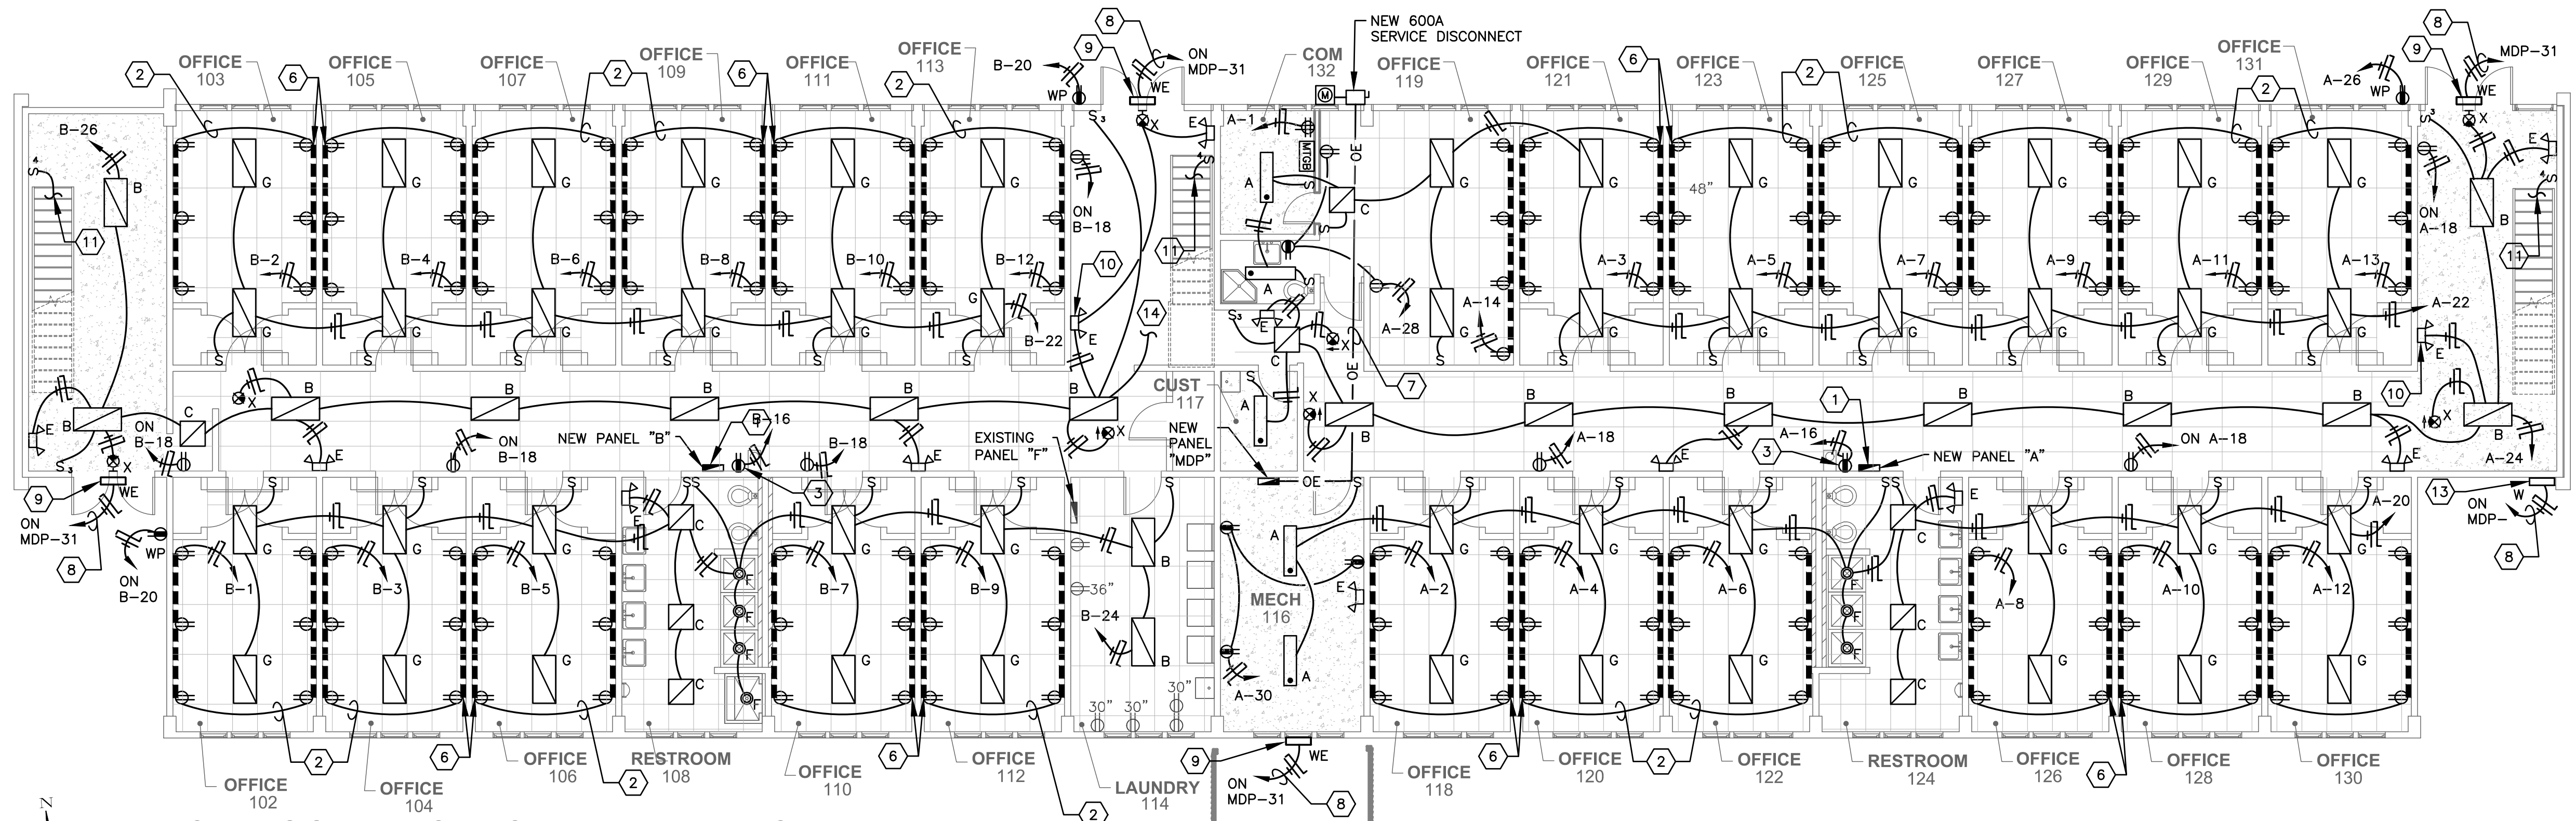

2 SECOND FLOOR ELECTRICAL PLAN - REVISED

SCALE: 1/8"=1'-0"

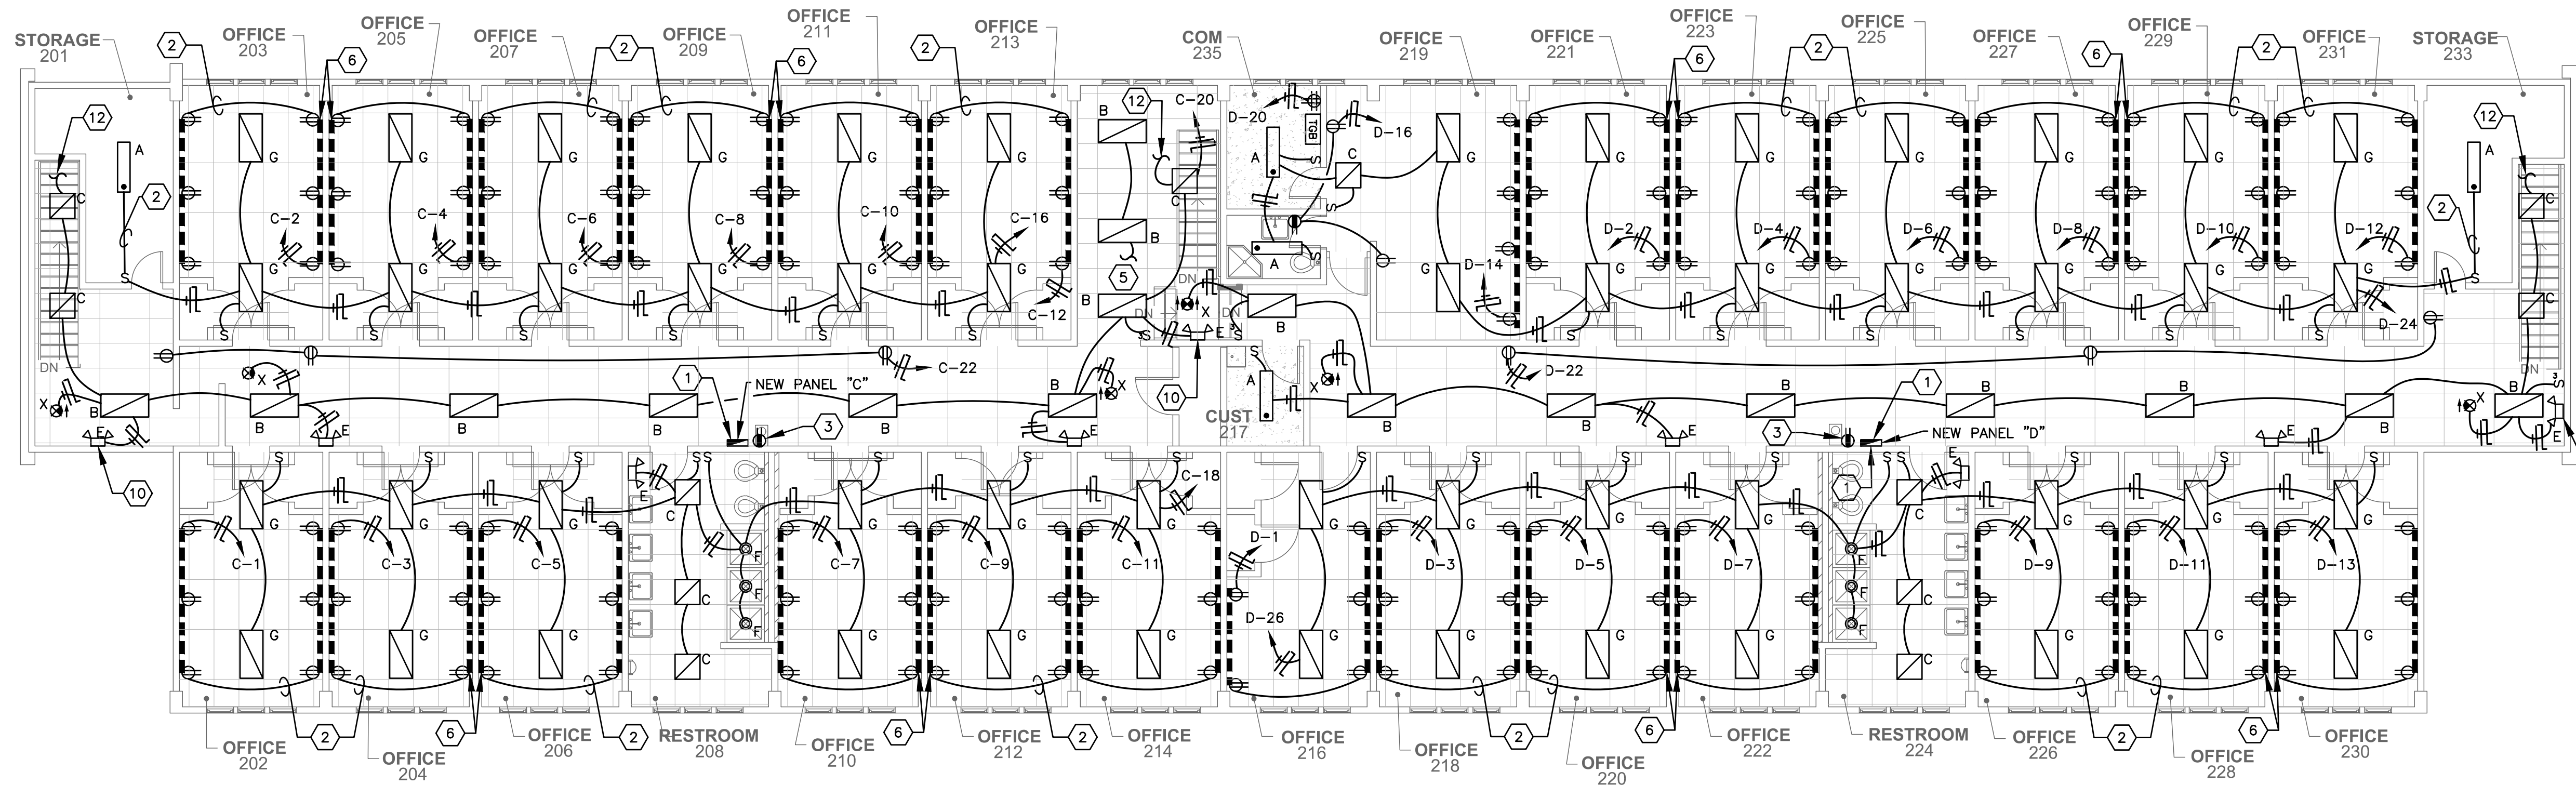GENERAL NOTES

1. REFER TO ELECTRICAL SYMBOL LEGEND AND ELECTRICAL GENERAL NOTES FOR ADDITIONAL INFORMATION.
2. NEW LIGHTING FIXTURES TO BE INSTALLED IN SAME LOCATION AS DEMOLISHED FIXTURE UNLESS NOTED OTHERWISE. REFER TO LIGHT FIXTURE SCHEDULE FOR FIXTURE TYPE.
3. UNDER AN ALTERNATE THE CONTRACTOR SHALL REMOVE AND REPLACE ALL WALL SWITCHES IN OFFICES WITH LINE VOLTAGE, DUAL TECHNOLOGY OCCUPANCY SENSOR SWITCH.

KEYED NOTES

- 1 NEW PANEL BOARD SHALL BE SURFACE MOUNTED IN THE SAME LOCATION AS THE PREVIOUS PANEL BOARD. CONTRACTOR SHALL MODIFY DEMOLISHED PANEL BOARD OPENING AS NECESSARY FOR A FLUSH MOUNTING. EXPOSED CONDUITS SHALL BE PAINTED TO MATCH ADJACENT SURFACE. REFER TO PANEL SCHEDULES FOR ADDITIONAL INFORMATION.
- 2 PROVIDE 700 SERIES RACEWAY THROUGHOUT OFFICE SPACE.
- 3 PROVIDE GFCI TYPE RECEPTACLE FOR EXISTING EWC.
- 4 NEW DISTRIBUTION PANEL "MDP", 120/208V, 3Ø, 4 WIRE. REFER TO PANEL SCHEDULE FOR ADDITIONAL INFORMATION.
- 5 EXTEND TO LIGHT FIXTURE ON FIRST FLOOR. REFER TO KEYED NOTE 14 ON THIS SHEET FOR CONTINUATION.
- 6 PROVIDE 5400 SERIES MULTI COMPARTMENT NONMETALLIC WIREMOLD AT 18" A.F.F. WIREMOLD SHALL RUN THE LENGTH SHOWN WITH NUMBER OF RECEPTACLES SHOWN. SPARE COMPARTMENT FOR OWNER PROVIDED AND INSTALLED DATA DEVICES. CONTRACTOR SHALL PROVIDE SPARE DEVICE BRACKETS WITH BLANK FACEPLATES TO MATCH NUMBER OF RECEPTACLES FOR FUTURE OWNER PROVIDED AND INSTALLED DATA DEVICES. PROVIDE (2) 3/4" CONDUITS UP TO NEAREST ACCESSIBLE CEILING FOR POWER AND COMMUNICATIONS. CONTRACTOR SHALL PROPERLY SUPPORT CONDUITS TO WALL AND PAINT TO MATCH ADJACENT SURFACE. REFER TO TYPICAL WIREMOLD INSTALLATION DETAIL 7 ON SHEET E4.0.(TYPICAL)
- 7 APPROXIMATE ROUTING OF NEW OVERHEAD LINES. REFER TO ELECTRICAL RISER DIAGRAM FOR SIZE AND NUMBER OF CONDUITS AND WIRES.
- 8 EXTEND THROUGH EXISTING OUTSIDE LIGHTING CONTACTOR.
- 9 MOUNT 12" ABOVE FINISH FLOOR ABOVE DOOR/WINDOW FRAME. FIELD COORDINATE EXACT MOUNTING HEIGHT WITH OWNER PRIOR TO ROUGH-IN.
- 10 MOUNT EMERGENCY LIGHTS "E" 6" BELOW CEILING GRID/CEILING STRUCTURE.(TYPICAL)
- 11 EXTEND AND CONNECT TO RESPECTIVE CIRCUIT CONNECTED TO SECOND FLOOR LIGHTING.
- 12 EXTEND AND CONNECT TO RESPECTIVE CIRCUIT CONNECTED TO FIRST FLOOR SWITCH.
- 13 MOUNT FIXTURE AT PREVIOUS FLOOD LIGHT LOCATION. CONTRACTOR SHALL PROVIDE NEW WIRES BACK TO SOURCE TO AVOID SPLICING.
- 14 EXTEND TO LIGHT FIXTURE ON SECOND FLOOR. REFER TO KEYED NOTE 5 ON THIS SHEET FOR CONTINUATION.

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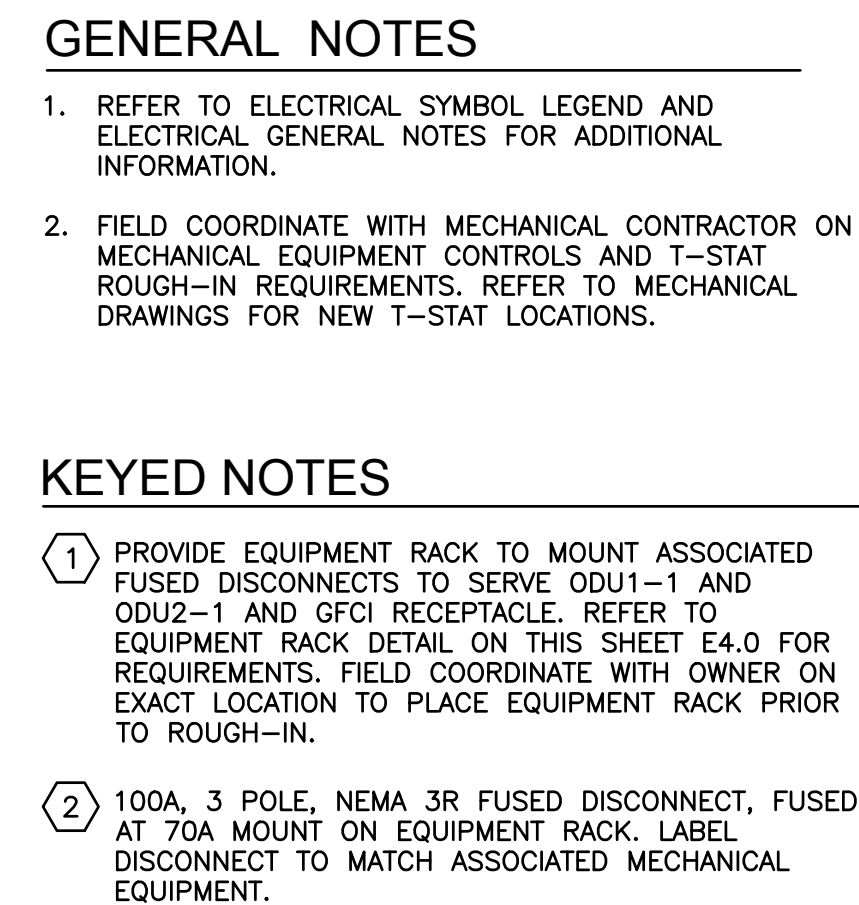
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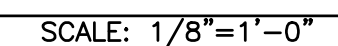
1ST AND 2ND FLOOR
ELECTRICAL PLANS - REVISED


NEW MEXICO TECH WEST HALL


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3619
DRAWING NO.
E3.1



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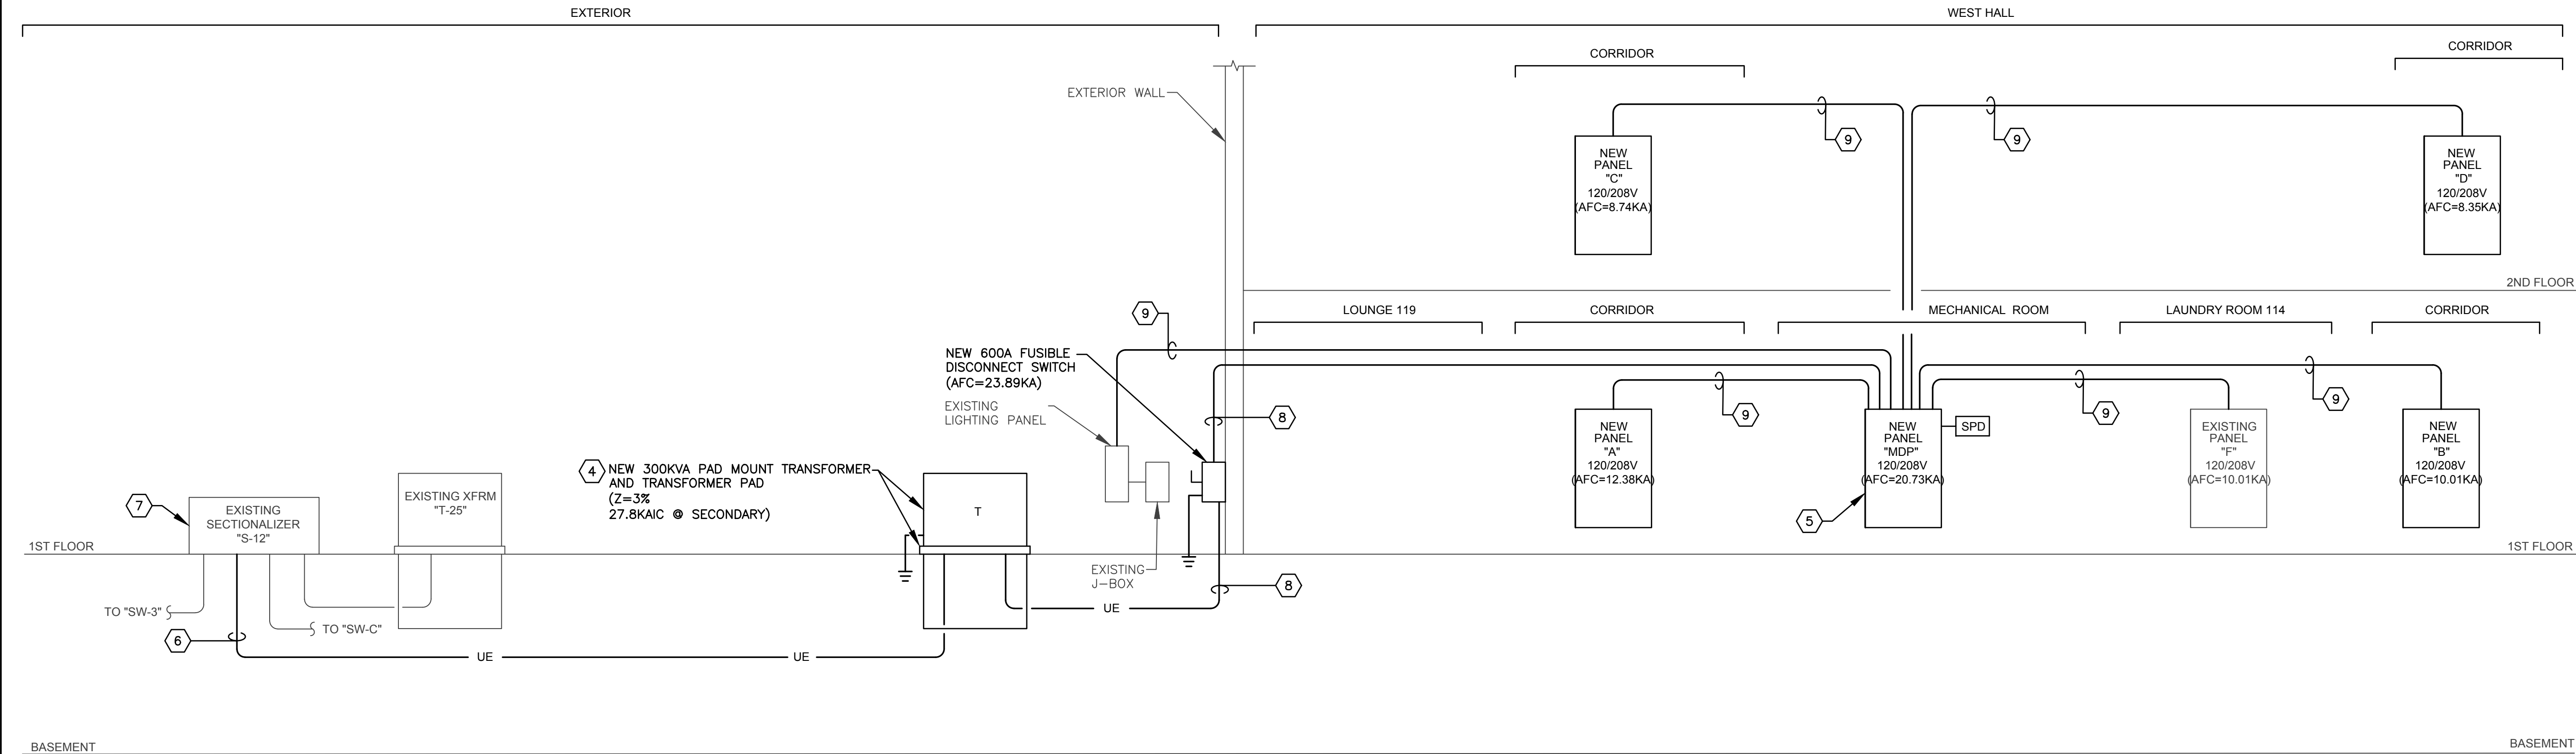


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				DRAWN CAD	DRAWING NO. E3.2			
				CHECKED JG				
				DATE 01/15/20				
REV.	DATE	BY	DESCRIPTION					
							NEW MEXICO TECH WEST HALL	

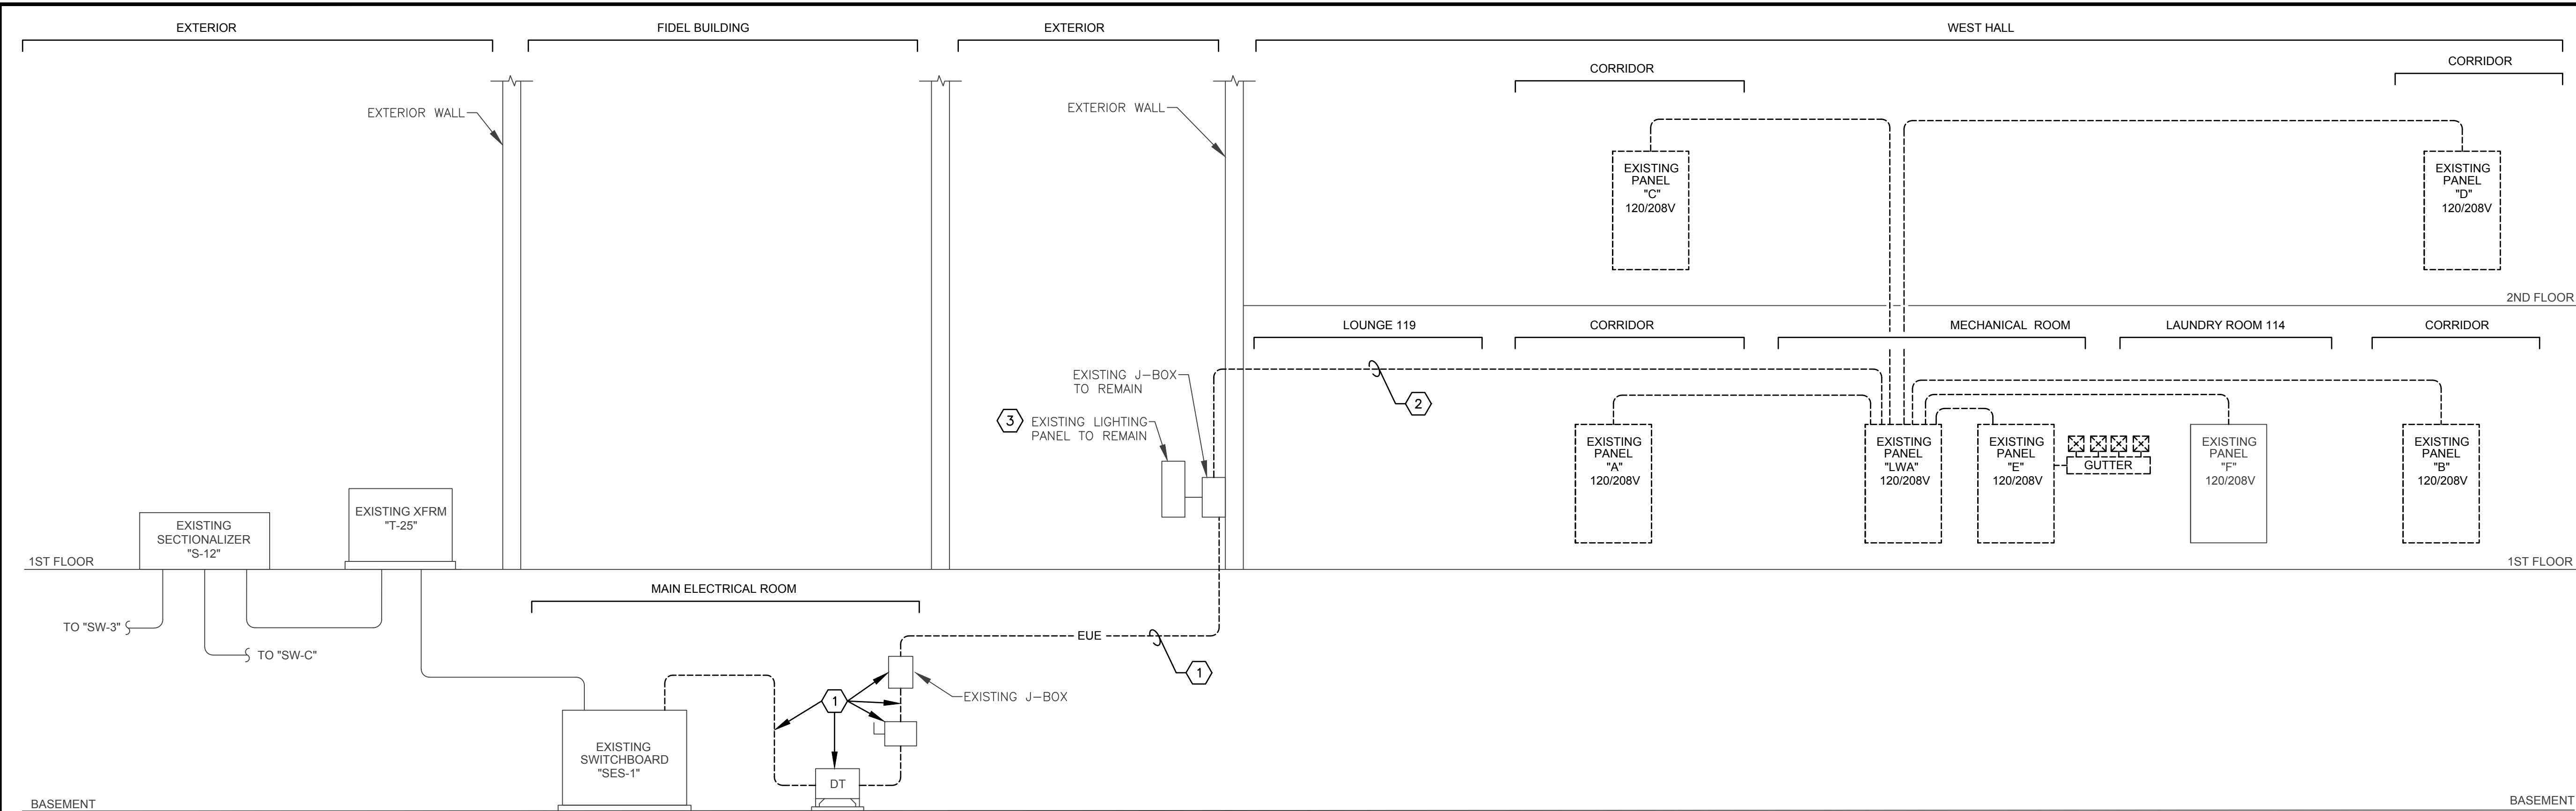

1 ELECTRICAL RISER DIAGRAM - DEMOLITION

SCALE: NTS



2 ELECTRICAL RISER DIAGRAM - REVISED

SCALE: NTS

GENERAL NOTES

1. REFER TO ELECTRICAL LEGEND AND ELECTRICAL GENERAL NOTES FOR ADDITIONAL INFORMATION.
2. ELECTRICAL CONTRACTOR SHALL PROVIDE SHORT CIRCUIT COORDINATION AND ARCH FLASH STUDY.

KEYED NOTES

- 1 CONTRACTOR SHALL DISCONNECT AND REMOVE WIRING FROM EXISTING SWITCHBOARD "SES-1" TO EXISTING J-BOX, LOCATED AT THE EXTERIOR OF WEST HALL. ALL EXPOSED CONDUITS AND UNDERGROUND CONDUITS SHALL BE CAPPED AND ABANDONED IN PLACE. EXISTING DISCONNECT SWITCH, DRY TYPE TRANSFORMER AND J-BOX SHALL BE SALVAGED BACK TO OWNER. COORDINATE WITH NEW MEXICO TECH PRIOR TO COMMENCING WORK.
- 2 CONTRACTOR SHALL REMOVE FURR-OUT IN LOUNGE 119 AND REMOVE ALL CONDUITS AND WIRING UP TO PANEL "LWA". REFER TO SHEET ED1.01 FOR ADDITIONAL INFORMATION.
- 3 EXISTING LIGHTING PANEL TO REMAIN. REFER TO REVISED RISER DIAGRAM FOR NEW WORK REQUIRED.
- 4 ALL WORK ASSOCIATED WITH THE SERVICE ENTRANCE SHALL BE COORDINATED AND VERIFIED WITH NEW MEXICO TECH. AND SHALL MEET ALL THEIR STANDARDS AND REQUIREMENTS.
- 5 NEW 600AMP, 120/208V, 3Ø PANEL. REFER TO PANEL SCHEDULES FOR CONDUCTOR SIZE OF PANELS BEING SERVED FROM NEW DISTRIBUTION PANEL "MDP".
- 6 PROVIDE 15KV, 200AMP LOAD BREAK ELBOW CONNECTORS WITH INTEGRAL JACKET SEAL, #COOPER POWER SERIES, #LES215 OR EQUAL. ELBOW TYPE AND SIZE SHALL BE PROVIDED IN COORDINATION WITH POWER CABLE TO ACCEPT CABLE INSULATION SIZE.
- 7 SECTIONALIZER "S-12" IS SHALL BETTER SCSD-3154-22-22-GA-BX. CONTRACTOR SHALL PROVIDE 15KV LOADBREAK BUSHING INSERT, #COOPER POWER SERIES #LB1215 OR EQUAL IF LOADBREAK BUSHINGS ARE NOT AVAILABLE.
- 8 (2) SETS OF 3" CONDUITS EACH WITH (4)#350 KCMIL + #1 GROUND.
- 9 REFER TO PANEL SCHEDULES ON SHEET E6.0 FOR SIZING AND NUMBER OF CONDUIT AND WIRES.

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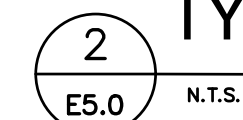
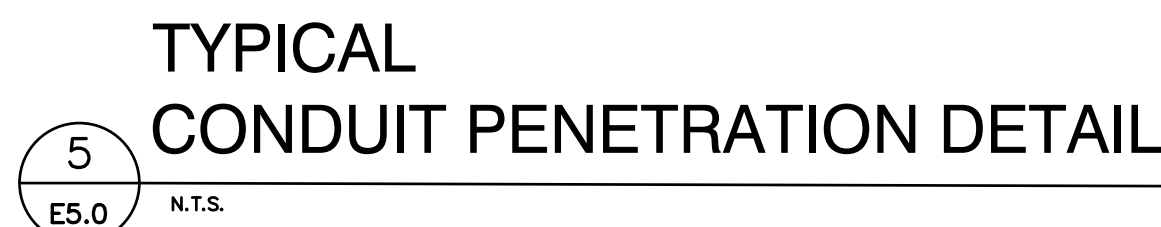
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ELECTRICAL RISER DIAGRAMS

NEW MEXICO TECH WEST HALL

JOB NO.
3619
DRAWING NO.
E4.0




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1. THE CONTRACTOR SHALL REFER TO THE ARCHITECTURAL, STRUCTURAL, CIVIL, MECHANICAL AND PLUMBING DEMOLITION WORK DRAWINGS TO DETERMINE AND COORDINATE THE EXTENT OF THE DEMOLITION WORK REQUIRED FOR THE PROJECT.
2. THE CONTRACTOR SHALL VISIT THE SITE DURING THE BIDDING PERIOD TO COMPLETELY FAMILIARIZE SELF WITH THE SCOPE OF WORK, CONDITIONS, AND VERIFY FIELD MEASUREMENTS AND CIRCUITING ARRANGEMENTS FOR THIS PROJECT AND INCLUDE IN THE BID ALL NECESSARY COSTS ASSOCIATED WITH COMPLETION OF THE WORK.
3. DEMOLITION DRAWINGS ARE BASED ON CASUAL FIELD OBSERVATION AND EXISTING RECORD DOCUMENTS. REPORT DISCREPANCIES TO ARCHITECT/ENGINEER BEFORE DISTURBING EXISTING INSTALLATIONS. BEGINNING OF DEMOLITION MEANS INSTALLER ACCEPTS EXISTING CONDITIONS.
4. DEMOLITION WORK CONSISTS OF AND IS NOT LIMITED TO THE REMOVAL, RELOCATION, STORAGE, AND DISPOSAL OF EXISTING ELECTRICAL DISTRIBUTION EQUIPMENT, LIGHT FIXTURES, SWITCHES, POWER OUTLETS, FIRE-ALARM DEVICES, PUBLIC ADDRESS, TELEPHONE/ DATA SYSTEMS, AND ANY CONTROL POWER WIRING TO EXISTING MECHANICAL AND PLUMBING EQUIPMENT.
5. REMOVE ALL EXISTING BRANCH CIRCUITING AND EQUIPMENT (STARTERS, DISCONNECTS, DEVICES, WIRING, CABLES, AND CONDUIT), TO ALL LOADS THAT ARE BEING REMOVED BACK TO THE SOURCE OF SUPPLY UNLESS NOTED OTHERWISE.
6. DEMOLISH AND EXTEND EXISTING ELECTRICAL WORK AS INDICATED OR NOTED. REMOVE, RELOCATE, AND EXTEND EXISTING INSTALLATIONS TO ACCOMMODATE NEW CONSTRUCTION.
7. REMOVE EXPOSED ABANDONED CONDUIT AND WIRING TO SOURCE OF SUPPLY IN ITS ENTIRETY, INCLUDING ABANDONED CONDUIT ABOVE ACCESSIBLE CEILING FINISHES. CUT CONDUIT FLUSH WITH WALLS AND FLOORS, REMOVE ALL WIRING, AND PATCH SURFACES.
8. DISCONNECT ABANDONED OUTLETS AND REMOVE DEVICES. REMOVE ABANDONED OUTLETS IF CONDUIT SERVICING THEM IS ABANDONED AND REMOVED. PROVIDE BLANK COVER FOR ABANDONED OUTLETS WHICH ARE NOT REMOVED.
9. DISCONNECT AND REMOVE ABANDONED PANELBOARDS, DISTRIBUTION EQUIPMENT AND LUMINAIRES. REMOVE BRACKETS, STEMS, HANGERS, AND OTHER ACCESSORIES.
10. CONTRACTOR SHALL CIRCUIT TRACE ALL CIRCUITS AND EQUIPMENT THAT ARE BEING REMOVED OR RELOCATED. PRIOR TO DEMOLITION, CIRCUIT TRACE CIRCUITS SERVING OTHER SYSTEMS OR AREAS NOT BEING REMOVED AND INSURE THEY REMAIN FUNCTIONAL. MODIFY CONDUIT AND WIRING TO MAINTAIN CIRCUIT CONTINUITY TO REMAINING AREAS. RE-CIRCUIT THESE AREAS TO REMAINING PANELS AS REQUIRED.
11. COORDINATE UTILITY SERVICE OUTAGES WITH UTILITY COMPANY.
12. PROVIDE TEMPORARY WIRING AND CONNECTIONS TO MAINTAIN EXISTING SYSTEMS IN SERVICE DURING CONSTRUCTION. WHEN WORK MUST BE PERFORMED ON ENERGIZED EQUIPMENT OR CIRCUITS, USE PERSONNEL EXPERIENCED IN SUCH OPERATIONS.
13. EXISTING ELECTRICAL SERVICE: MAINTAIN EXISTING SYSTEM IN SERVICE UNTIL NEW SYSTEM IS COMPLETE AND READY FOR SERVICE. DISABLE SYSTEM ONLY TO MAKE SWITCHOVERS AND CONNECTIONS. PROVIDE PORTABLE TEMPORARY GENERATOR FOR OUTAGES EXTENDING LONGER THAN ONE (1) HOUR. OBTAIN PERMISSION FROM OWNER AT LEAST 24 HOURS BEFORE PARTIALLY OR COMPLETELY DISABLING SYSTEM. MINIMIZE OUTAGE DURATION. MAKE TEMPORARY CONNECTIONS TO MAINTAIN SERVICE IN AREAS ADJACENT TO WORK AREA.
14. EXISTING FIRE ALARM SYSTEM: MAINTAIN EXISTING SYSTEM IN SERVICE UNTIL NEW SYSTEM IS ACCEPTED. DISABLE SYSTEM ONLY TO MAKE SWITCHOVERS AND CONNECTIONS. PROVIDE FIRE WATCH AS REQUIRED PER LOCAL AUTHORITY HAVING JURISDICTION DURING DOWN TIME. NOTIFY OWNER AND LOCAL FIRE SERVICE AT LEAST 24 HOURS BEFORE PARTIALLY OR COMPLETELY DISABLING SYSTEM. MINIMIZE OUTAGE DURATION. MAKE TEMPORARY CONNECTIONS TO MAINTAIN SERVICE IN AREAS ADJACENT TO WORK AREA.
15. EXISTING TELEPHONE, PUBLIC ADDRESS, SECURITY, CLOCK SYSTEMS: MAINTAIN EXISTING SYSTEMS IN SERVICE UNTIL NEW SYSTEMS ARE COMPLETE AND READY FOR SERVICE. DISABLE SYSTEMS ONLY TO MAKE SWITCHOVERS AND CONNECTIONS. NOTIFY OWNER AND TELEPHONE UTILITY COMPANY AT LEAST 24 HOURS BEFORE PARTIALLY OR COMPLETELY DISABLING SYSTEM. MINIMIZE OUTAGE DURATION. MAKE TEMPORARY CONNECTIONS TO MAINTAIN SERVICE IN AREAS ADJACENT TO WORK AREA.
16. MAINTAIN ACCESS TO EXISTING ELECTRICAL INSTALLATIONS WHICH REMAIN ACTIVE. MODIFY INSTALLATION OR PROVIDE ACCESS AS APPROPRIATE.
17. EXTEND EXISTING INSTALLATIONS USING MATERIALS AND METHODS COMPATIBLE WITH EXISTING ELECTRICAL INSTALLATIONS, OR AS INDICATED OTHERWISE.



1. REFER TO ELECTRICAL LEGEND AND ELECTRICAL GENERAL NOTES FOR ADDITIONAL INFORMATION.
2. CONTRACTOR SHALL CONFIRM EXACT LOCATION OF ALL UNDERGROUND UTILITIES PRIOR TO DEMOLITION.

- ① CONTRACTOR SHALL REMOVE ALL WIRING FROM "SES-1" IN MAIN ELEC. ROOM OF FIDEL BUILDING TO EXISTING PANEL "LWA" IN WEST HALL. ALL UNDERGROUND CONDUITS SHALL BE CAPPED AND ABANDONED IN PLACE.
- ② REMOVE CONDUIT AND WIRING IN THEIR ENTIRETY WITH STAFF HANDS. DURING, CONTRACTOR SHALL COORDINATE REMOVAL AND REPLACEMENT OF DAMAGED FURR--OUT. REPLACE AND PAINT FURR--OUT TO MATCH ADJACENT WALLS.
- ③ CONTRACTOR SHALL LABEL 150A, 3 POLE CIRCUIT BREAKER IN EXISTING "SES-1" CURRENTLY SERVING WEST HALL PANEL "LWA" AS SPARE.

				DESIGNED ES		<p>"This preliminary drawing is released for the purpose of owner review under the authority of Joder Garcia, P.E., New Mexico Professional Engineer Number 14969 on January 26, 2021. This drawing is not to be used for construction, bidding, or permitting purposes. Alterations of this document is an offense under the New Mexico Engineering Practice Act."</p> <div><p>TEXAS FIRM REGISTRATION NO. 829 4110 RIO BRAVO SUITE 102 EL PASO, TX 79902 TEL: 915-313-7200</p></div>		ELECTRICAL SITE PLAN - DEMOLITION	JOB NO. 3619
				DRAWN CAD			DRAWING NO. ED1.0		
				CHECKED JG					
				DATE 01/15/20					
REV.	DATE	BY	DESCRIPTION					NEW MEXICO TECH WEST HALL	